PHILMONT BEAUTIFICATION RENOVATION

PHILMONT, NY JUNE 2016



DRAWING LEGEND

G-001- TITLE PAGE

A-101 - FIRST FLOOR PLAN

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M-101 - PROPANE/HOOD SYSTEM PLAN

M-102 - HEATING/COOLING SYSTEM PLAN

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E-101 - ELECTRICAL PLAN

AD-1 - PARTIAL FLOOR PLAN

D-1 - SITE PLAN


D-3 - PROPOSED SIGNAGE

GENERAL NOTES:

- 1. CONTRACTOR SHALL VERIFY ALL EXISTING CONDITION PRIOR TO PERFORMING WORK. ALL DISCREPANCIES OBSERVED SHOULD IMMEDIATELY BE BROUGHT TO THE ATTENTION OF THE DESIGN PROFESSIONAL.
- 2. ALL NEW ELECTRICAL WORK SHALL BE CONSTRUCTED IN ACCORDANCE WITH THE NEW YORK STATE BUILDING CODE CH. 27
- 3. ALL NEW MECHANICAL WORK SHALL BE CONSTRUCTED IN ACCORDANCE WITH THE NEW YORK STATE BUILDING CODE CH. 28
- 4. ALL NEW PLUMBING WORK SHALL BE CONSTRUCTED IN ACCORDANCE WITH THE NEW YORK STATE BUILDING CODE CH. 29
- 5. AT LEAST ONE SINGLE—STATION CARBON MONOXIDE DETECTING ALARM DEVICE, INSTALLED IN CONFORMITY WITH THE NEW YORK STATE BUILDING CODE RULES AND REGULATIONS, SHALL BE PROVIDED ADJACENT TO SLEEPING SPACES ON EACH FLOOR LEVEL AND SHALL BE LOCATED ON OR NEAR THE CEILING.
- 6. AT LEAST ONE SINGLE STATION SMOKE ALARM DEVICE, IN ACCORDANCE w\ NFPA 72, SHALL BE PLACED ON EACH FLOOR LEVEL, IN EACH BEDROOM AND ADJOINING HALLWAY. ALL ALARMS TO BE INTERCONNECTED IN SUCH A MANNER THAT THE ACTUATION OF ONE ALARM WILL ACTIVE ALL. SMOKE ALARMS TO BE HOT WIRED AND CONTAIN BATTERY BACKUP.
- 7. ALL WORK SHALL BE COMPLETED IN ACCORDANCE WITH THE NY STATE BUILDING CODE & OTHER APPLICABLE CODES.
- 8. ARCHITECTURAL DRAWINGS ARE IN PART ILLUSTRATIVE AND DO NOT NECESSARILY SHOW FULL CONSTRUCTION DETAILING, REQUIRED MATERIALS, PERFORMANCE OR INSTALLATION METHODOLOGY, & DO NOT NECESSARILY INCORPORATE THE POSSIBLE IMPACTS ON BUILDING CONSTRUCTION OF OTHER ITEMS OF WORK / EQUIPMENT INSTALLATIONS.
- 9. IT IS THE RESPONSIBILITY OF THE CONTRACTOR TO PROVIDE PROPER MATERIAL & ITEM QUANTITIES, FIELD MEASUREMENTS, DIMENSIONAL SOLIDITY, INSTALLATION, ANCHORAGE, TEMPORARY SHORING, & TO COORDINATE w/ OTHER TRADES IN CONJUNCTION w/ BUT NOT LIMITED BY THESE PLANS.
- 10. GENERAL CONTRACTOR IS RESPONSIBLE TO VERIFY ALL FIELD CONDITIONS & NOTIFY ARCHITECT/OWNER IMMEDIATELY OF ANY INCONSISTENCIES OR DISCREPANCIES w/ EXISTING CONDITIONS & PLANS.
- 11. CONSULTANT SHEETS ARE AUXILIARY TO ARCHITECTURAL PLANS. CONTRACTOR SHALL REFERENCE STRUCTURAL, MECHANICAL, AND ELECTRICAL DRAWINGS/DESIGN FOR ITEMS AND/OR DETAILS NOT SHOWN ON ARCHITECTURAL DRAWINGS, & COORDINATE THIS WORK.
- 12. NOTED DIMENSIONS ON PLANS HAVE PRECEDENCE OVER SCALING.
- 13. ALL INTERIOR DIMENSIONS ARE TO FACE OF WALL STUD OR CENTERLINE OF DOOR/WINDOW UNLESS OTHERWISE NOTED.
- 14. ALL MANUFACTURED EQUIPMENT & MATERIALS SHALL BE INSTALLED & CONDITIONED PER MANUFACTURERS RECOMMENDATIONS INCLUDING ROOFING MATERIAL.
- 15. FIRE EXTINGUISHERS SHALL BE SUPPLIED & INSTALLED AS REQUIRED BY THE NY STATE BUILDING CODE.
- 16. ALL DOORS, WINDOWS, INTERIOR, FLOOR, & EXTERIOR FINISHES SHALL BE IN COMPLIANCE w/ THE NY STATE BUILDING CODE & DETERMINED BY OWNER.
- 17. GENERAL CONTRACTOR TO SUPPLY & INSTALL SOLID BLOCKING AT MOUNTING LOCATIONS FOR ALL MISCELLANEOUS EQUIPMENT INCLUDING BUT NOT LIMITED TO COUNTER TOPS, GRAB BARS, TOILET PARTITIONS, TOILET FIXTURES & GWB PARTITIONS.
- 18. CONTROL JOINTS TO BE PROVIDED & INSTALLED IN GWB PER MANUFACTURER'S RECOMMENDATIONS.
- 19. GENERAL CONTRACTOR SHALL BE RESPONSIBLE FOR THE PROTECTION OF ALL MATERIALS, FINISHES, & EQUIPMENT ON SITE DURING CONSTRUCTION & REPAIR OF ANY ITEMS/FINISHES DAMAGED AS A RESULT OF CONSTRUCTION WORK.
- 20. ALL OPENINGS TO BE CAULKED, SEALED OR WEATHER STRIPPED.

HAZARDOUS MATERIAL GENERAL NOTES:

- 1. ALL HAZARDOUS MATERIALS TO BE REMEDIATED AS REQUIRED PRIOR TO SITE ALTERING ACTIVITIES AND PRIOR TO OCCUPANCY OF THE BUILDING.
- 2. REMEDIATION TO BE DESIGNED AND COMPLETED BY OTHERS PER SITE ALTERATION LETTER (SAL) DATED JUNE 8, 2016, BY NEW YORK STATE HOMES AND COMMUNITY RENEWAL. SHARS NUMBER 20156002.

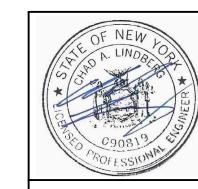

IT IS A VIOLATION OF THE NEW YORK STATE EDUCATION LAW
FOR ANY PERSON TO ALTER THESE PLANS, SPECIFICATIONS
OR REPORTS IN ANY WAY, UNIESS HE IS ACTING UNDER THE
DIRECTION OF A LICENSED PROFESSIONAL ENGINEER.

IITLE PAGE

PHILMONT EAUTIFICATION, INC.

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TACONIC ENGINEERING, DPC

TACONIC JOB# *16090* SHEET


DRAWN BY: GBS

DESIGNED BY: GBS

APPROVED BY: CAL

ISSUED

8/1/2016

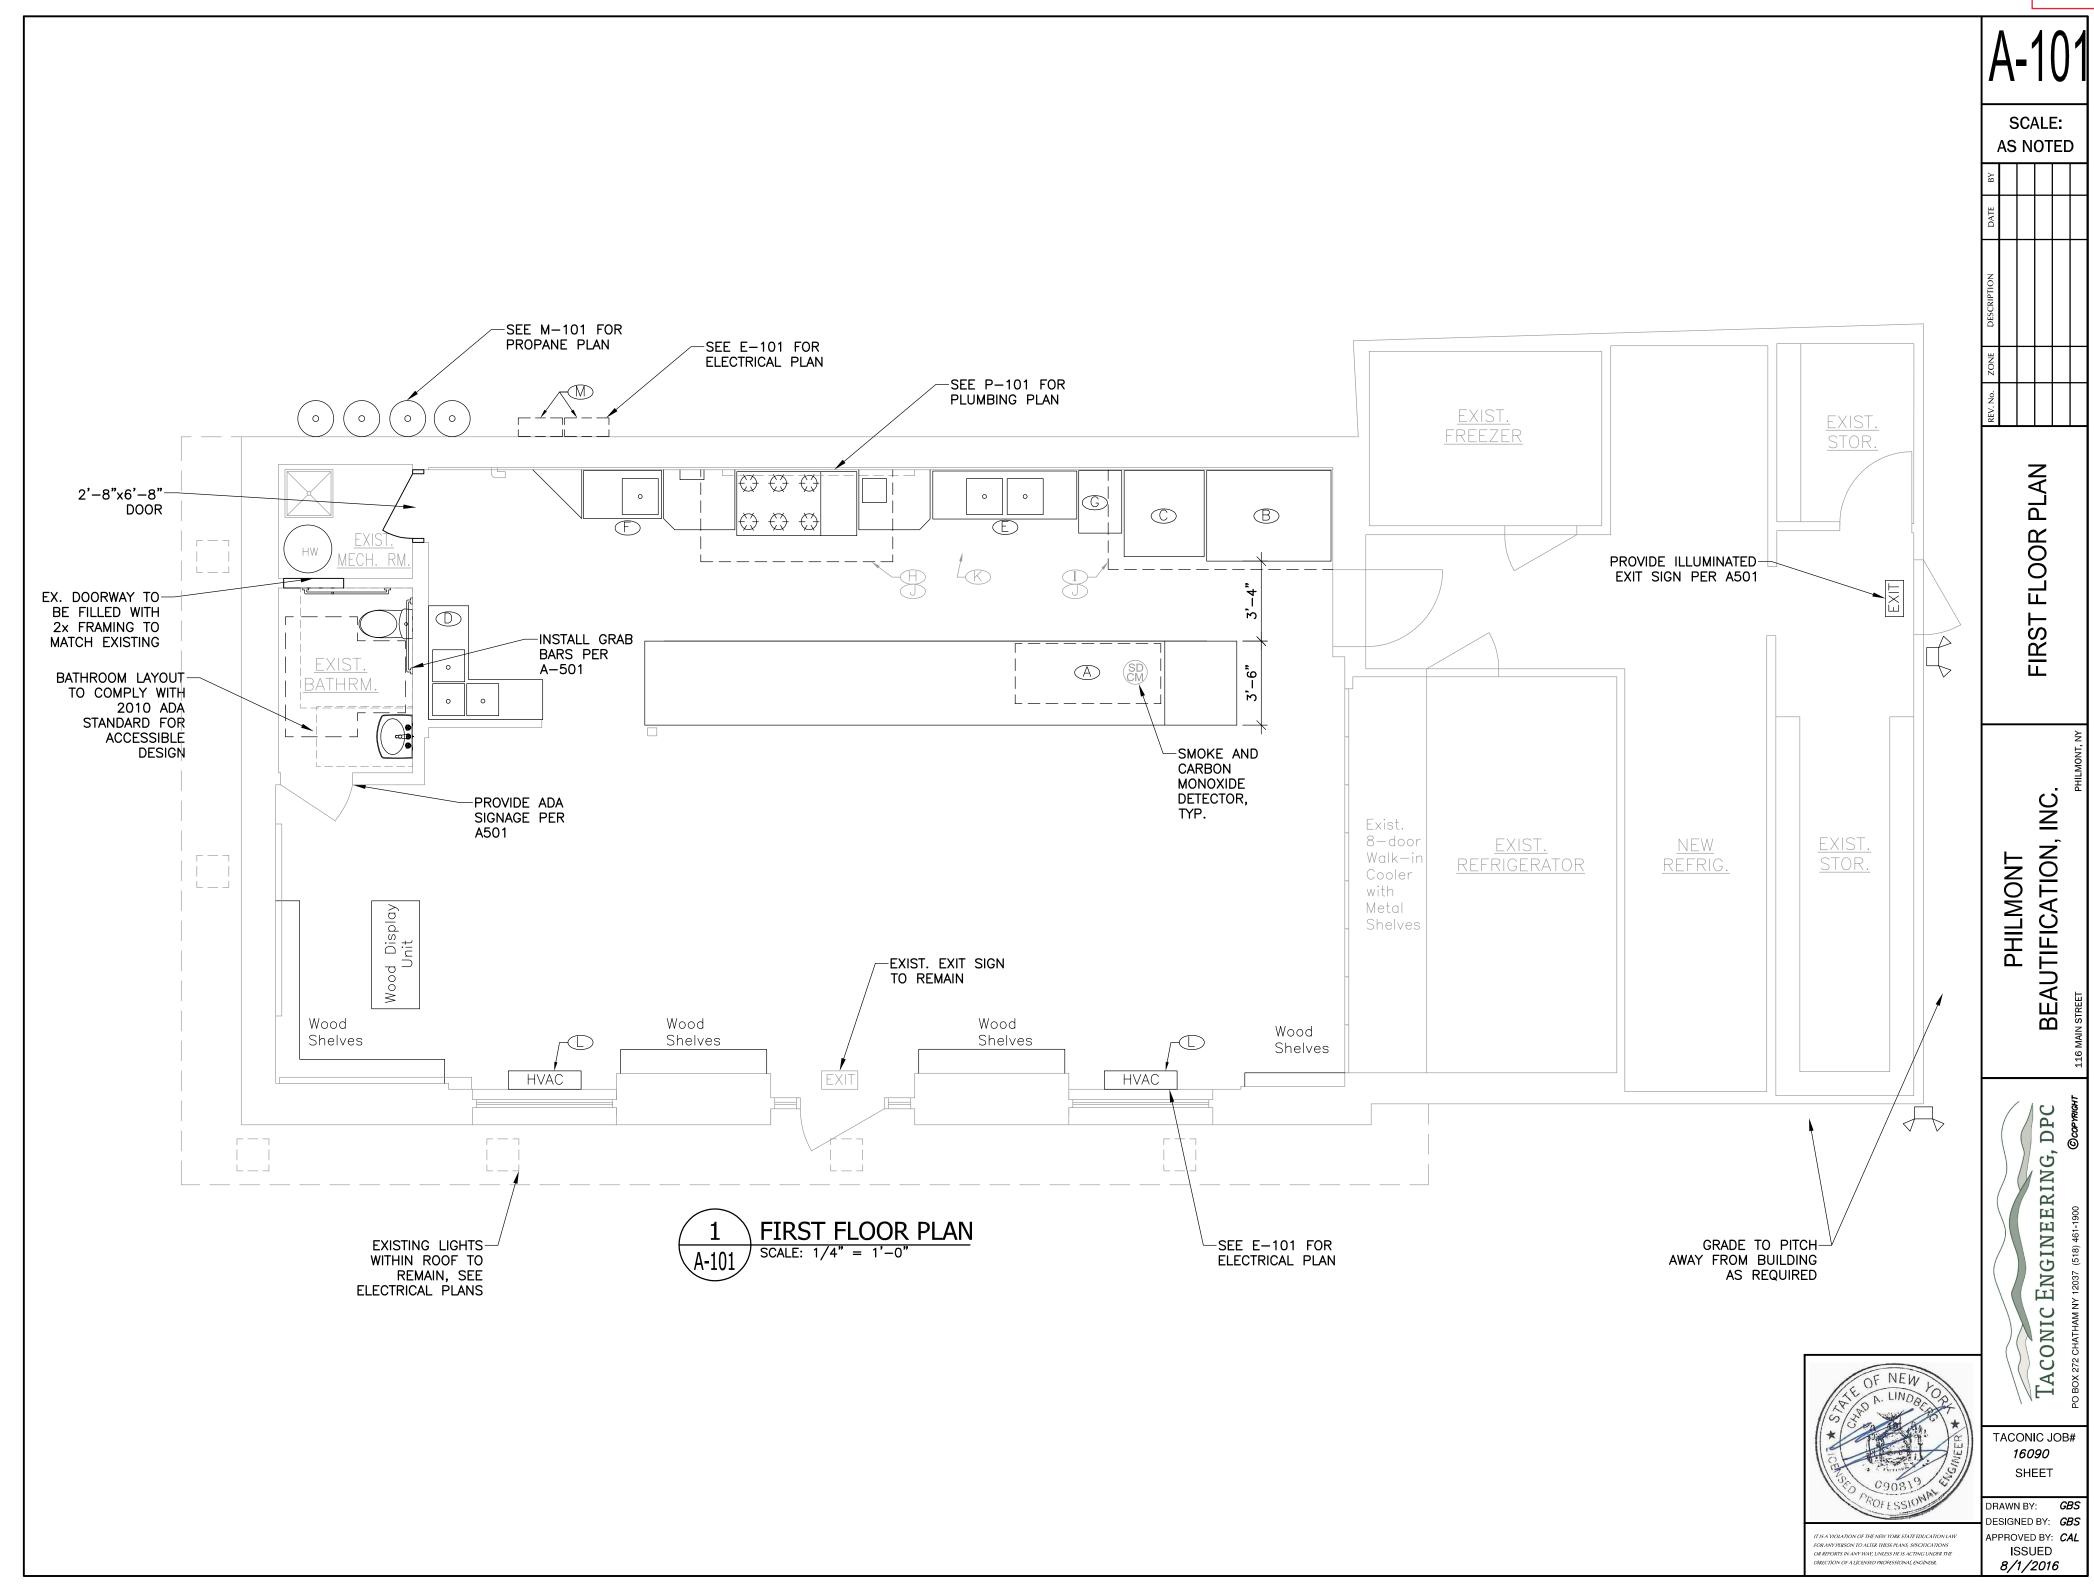

SCALE:

AS NOTED

ARCHITECTURAL

DETAIL:

EAUTIFICATION, INC

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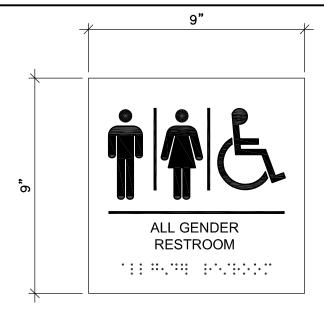
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ENGINEERING,

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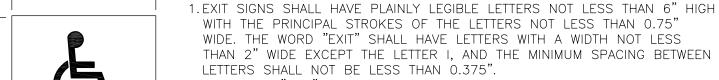




DIRECTIONAL SIGN

DIR

NOTES:




2. THE WORD "EXIT" SHALL BE IN HIGH CONTRAST WITH THE BACKGROUND AND SHALL BE CLEARLY DISCERNIBLE WHEN THE MEANS OF EXIT SIGN

ILLUMINATION IS OR IS NOT ENERGIZED. 3. THE FACE OF THE ILLUMINATED EXIT SIGN SHALL HAVE AN INTENSITY OF

NOT LESS THAN 5 FOOT CANDLES. 4.EXIT SIGNS SHOULD BE ILLUMINATED AT ALL TIMES. TO ENSURE CONTINUED ILLUMINATION FOR A A DURATION OF NOT LESS THAN 90 MINUTES IN CASE

OF PRIMARY POWER LOSS, THE SIGN ILLUMINATION MEANS SHALL BE CONNECTED TO AN EMERGENCY POWER SYSTEM PROVIDED FROM STORAGE BATTERIES, UNIT EQUIPMENT OR AN ON-SITE GENERATOR.

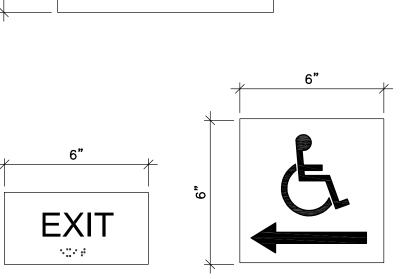



TACTILE EXIT SIGN

1. ALL SIGNAGE SHALL BE IN COMPLICANCE WITH THE NYSBC AND ANSI-117.1, INCLUDING BUT NOT LIMITED TO PROPORTION, COLOR CONTRAST AND RELIEF AND GRADE 2 BRAILLE REQUIREMENTS.


2. CLEARANCE AT DOORWAYS:

- PROVIDE AN 18" CLEARANCE ON THE PULL SIDE OF INTERIOR DOORS.
- PROVIDE A 24" CLEARANCE ON THE PULL SIDE OF THE EXTERIOR DOORS. • PROVIDE A 12" CLEARANCE ON THE PUSH SIDE OF ALL DOORS WHICH HAVE BOTH A LATCH AND A CLOSER.

3. TACTILE EXIT SIGNAGE:

- A TACTILE EXIT SIGN WITH THE WORD "EXIT" SHALL IDENTIFY EACH GRADE LEVEL EXTERIOR EXIT DOOR.
- A TACTILE EXIT SIGN WITH THE WORDS "EXIT ROUTE" SHALL IDENTIFY EACH EXIT ACCESS DOOR FROM AN INTERIOR ROOM OR AREA TO A CORRIDOR OR HALLWAY THAT IS REQUIRED TO HAVE A VISUAL EXIT SIGN.


 • GENERAL CONTRACTOR TO VERIFY EXISTING SIGNAGE INSTALLATIONS AND
- PROVIDE NEW AS REQUIRED. • CHARACTERS, SYMBOLS AND BACKGROUND SHALL HAVE A NON-GLARE
- CHARACTERS AND SYMBOLS SHALL CONTRAST WITH THE BACKGROUND, EITHER LIGHT ON DARK BACKGROUND OR DARK ON LIGHT BACKGROUND. • SIGNS TO INCLUDE BRAILLE AND CHARACTERS AS DEFINED BY CODE.
- SIGNS SHALL BE MOUNTED AT A MINIMUM HEIGHT OF 40" FROM THE FLOOR TO THE BASE LINE OF THE CHARACTERS

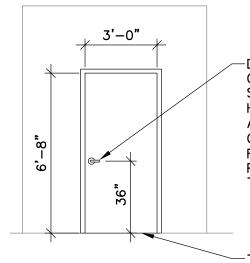


DOOR HANDLE TO BE LEVER OPERATED, PUSH TYPE, OR U SHAPED MECHANISMS, ALL HANDLES/HARDWARE TO BE ADA COMPLIANT & EASY TO GRASP IN (1) HAND & NOT REQUIRE TIGHT GRASPING, PINCHING OR TWISTING OF THE WRIST

-THRESHOLD, ½" MAX.


DOOR ELEVATION SCALE: N.T.S.

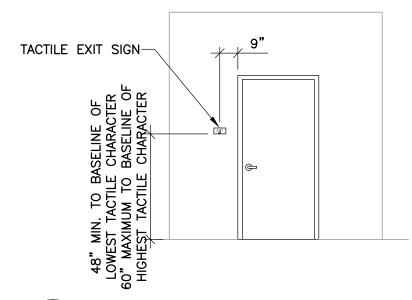

TACTILE EXIT SIGN LOCATION SCALE: N.T.S.

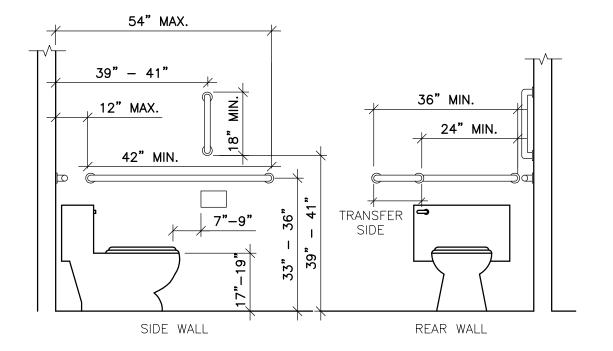




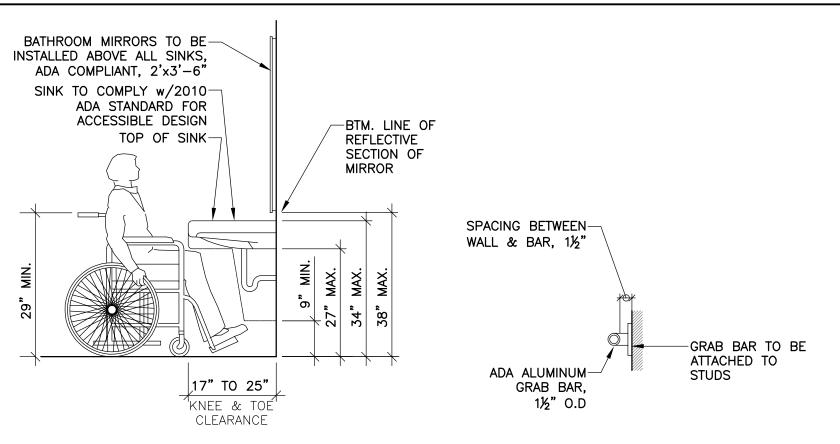





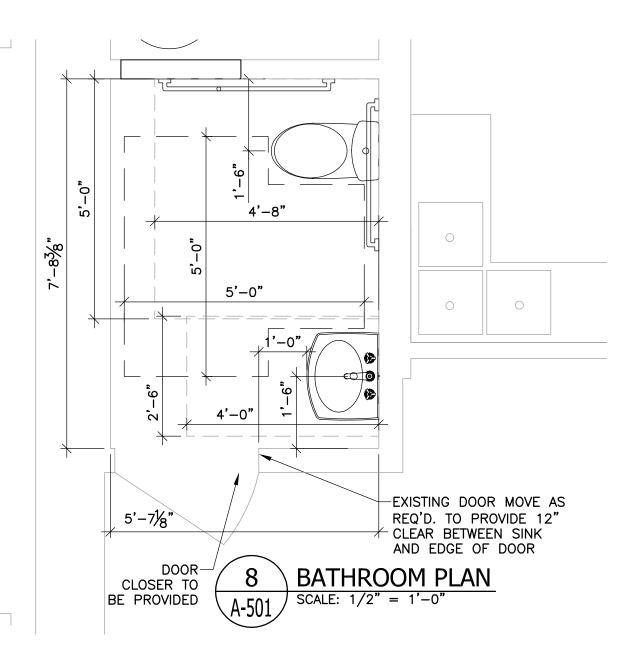



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TACONIC JOB# 16090 SHEET


DRAWN BY: ESIGNED BY: GBS APPROVED BY: CAL ISSUED 8/1/2016

EQUIPMENT SCHEDULE									
Mark	Quantity	ltem	NOTES						
		Kitchen Equipment:							
Α	1	Under-counter Refrigeration 3 door 19 cu ft TURBO AIR Model #894-134 72-3/4"L x 30"D x 36-3/8"H							
		Propane operated Pizza Oven Garland GPD-48-2 – Gas pizza – double							
В	1	Deck 63"W Model #595-260, 63"W x 62 ½"H x 45-1/4"D							
С	1	Propane operated – Convection Oven Garland – Economy Counter-top							
		Double stack Model #595-170, 74"H X 40W" X 44 ½"D							
D	1	Advance Tabco Corner Sink							
Е	1	Pot & Dish Compact Sink 72"W, 2 bowls, drainboards TURBO AIR Model #894-298, 72"W x 24"D x 44-1/2"H							
		Pot & Dish Compact Sink 39" W, 1 bowl, one drainboard TURBO AIR							
F	1	Model #894-294, 39"L X 24"D X 44 1/2"H							
G	1	Propane Proofing Holding Cabinet – non-insulated 691/2"H Winholt Model							
)	'	#942-032, 21"W X 30 3/4"L X 66 1/2"H							
		III a a de v (Ctairela de ata al vritte 2 li glata de la effica de grando a cura d							
Н	1	Hoods: (Stainless steel with 3 lights, s/s baffles, grease cups) model 5424Vx-2-PSP-F 8ft ansul							
Ţ	1	model 6024VX-2-PSP-F 8ft non-ansul							
1									
		Exhaust Blowers:							
J	2	model VXB14 ¾ H.P., 1920 cfm each wall mount							
1.7	4	Make-up Air Blowers:							
K	1	Filtered model VA2-G12 non-tempered 1.5HP 3072 cfm							
		HVAC:							
		2X Mitsubishi Heat Pump Installation 1-1/2 ton Mitsubishi MSZ/MUZ-							
L	2	FH18NA							
M	2	Wall Mount Condensers - Model # MUZ-FH15NA, hand held controllers,							
IVI		refrigeration piping, and condensate piping							
		Dames and First and a							
	1	Permanent Fixtures:							
	1	24ft prep table with stone counter top / cabinet maker retail display unit for dry goods, and interior shelving / cabinet maker							
	2	outdoor display units – wooden / cabinet maker / for store apron.							
		Flat Roof Solar:							

	A-60' SCALE: AS NOTED						
	BY						
	DATE						
	REV. No. ZONE DESCRIPTION						
	ZONE						
	REV. No.						
	EQUIPMENT SCHEDULE						
						ΔT, NY	

PHILMONT BEAUTIFICATION, INC.


TACONIC ENGINEERING, DPC

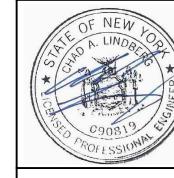

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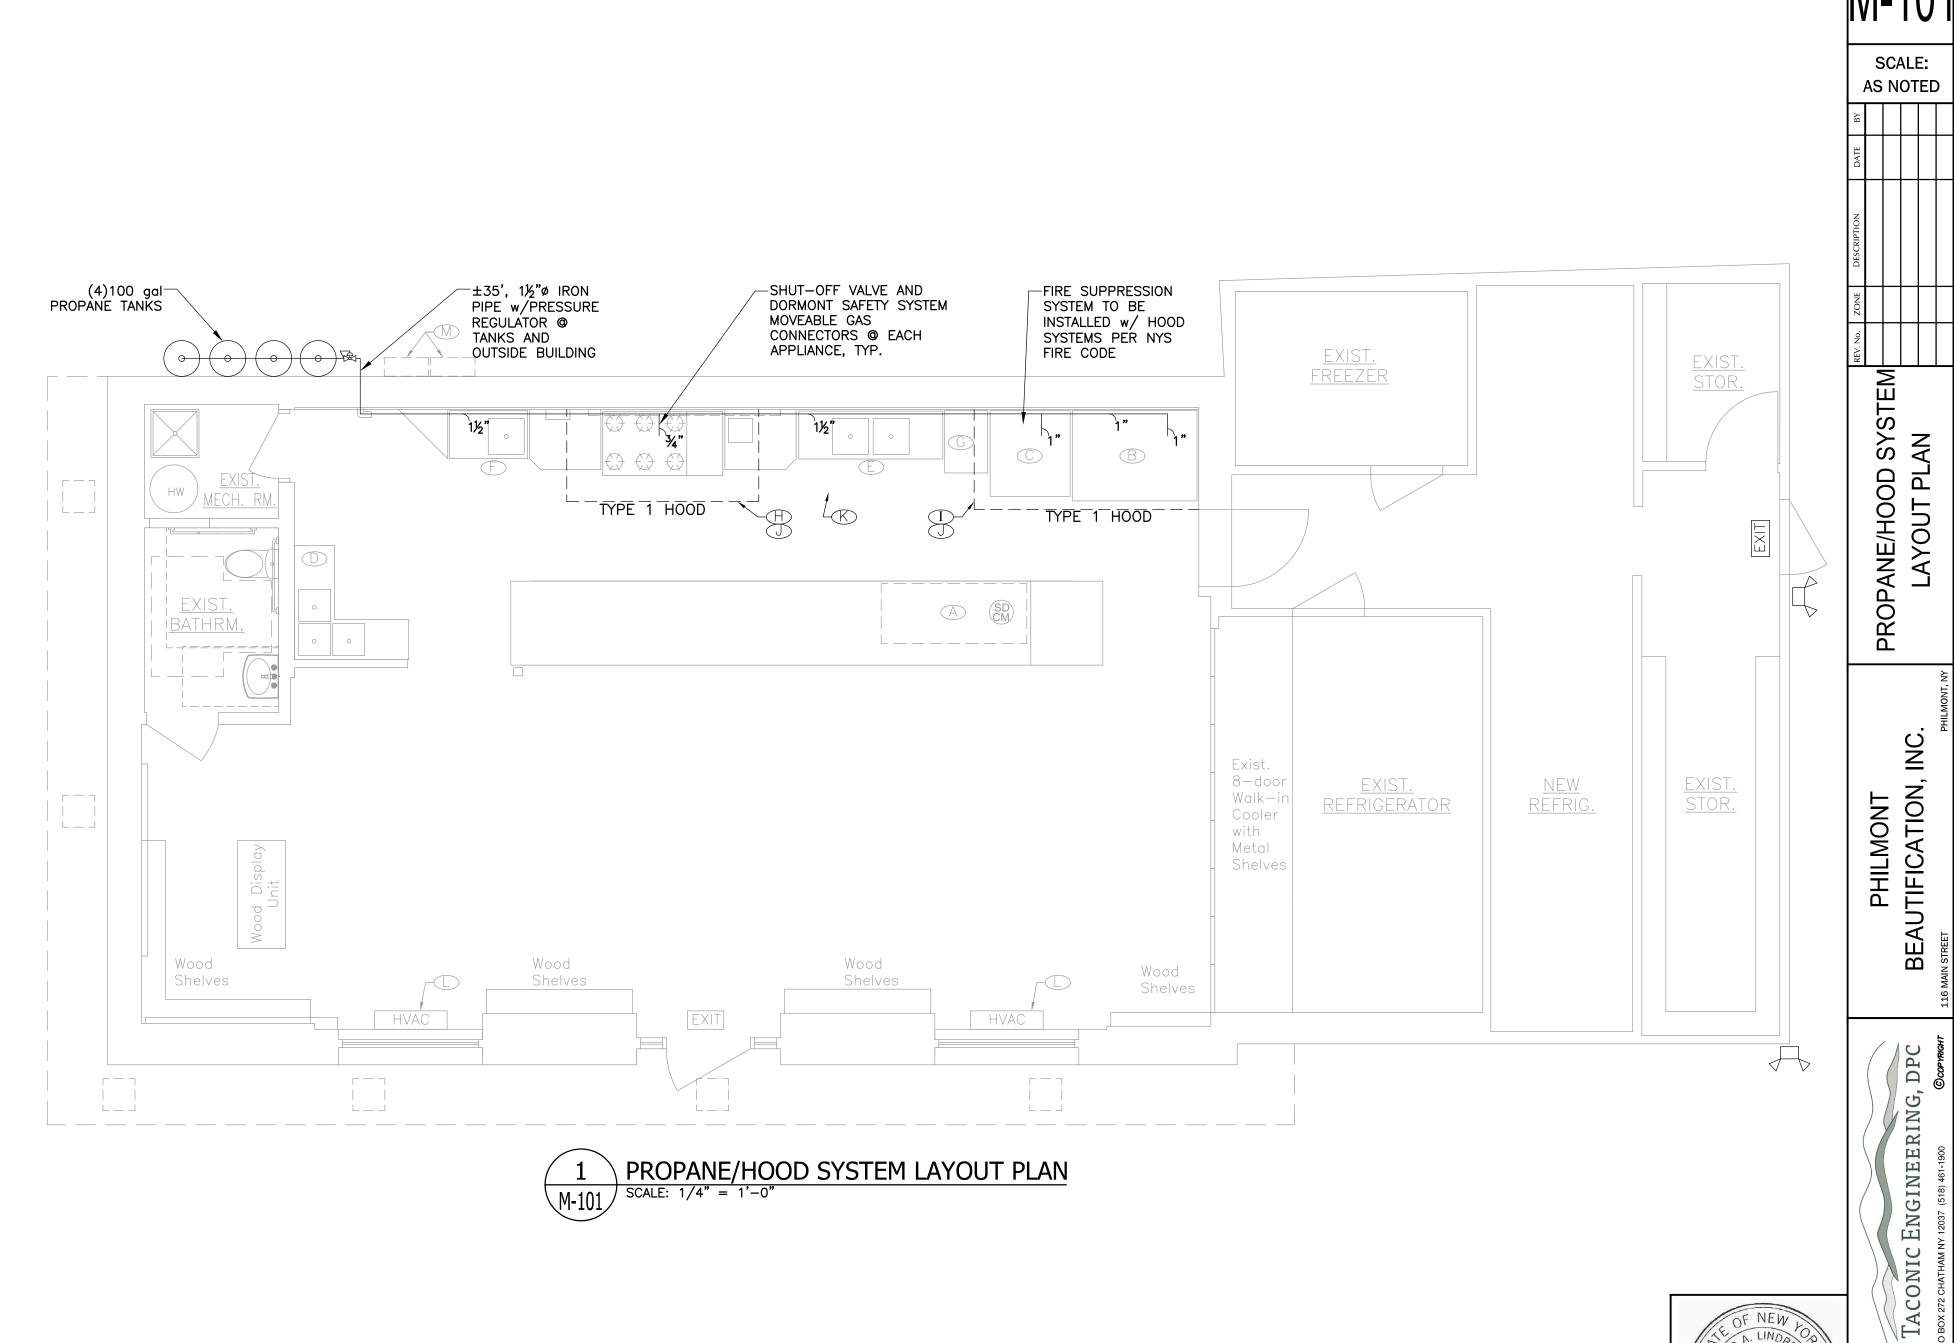
DIRECTION OF A LICENSED PROFESSIONAL ENGINEER

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LAYOUT PLAN


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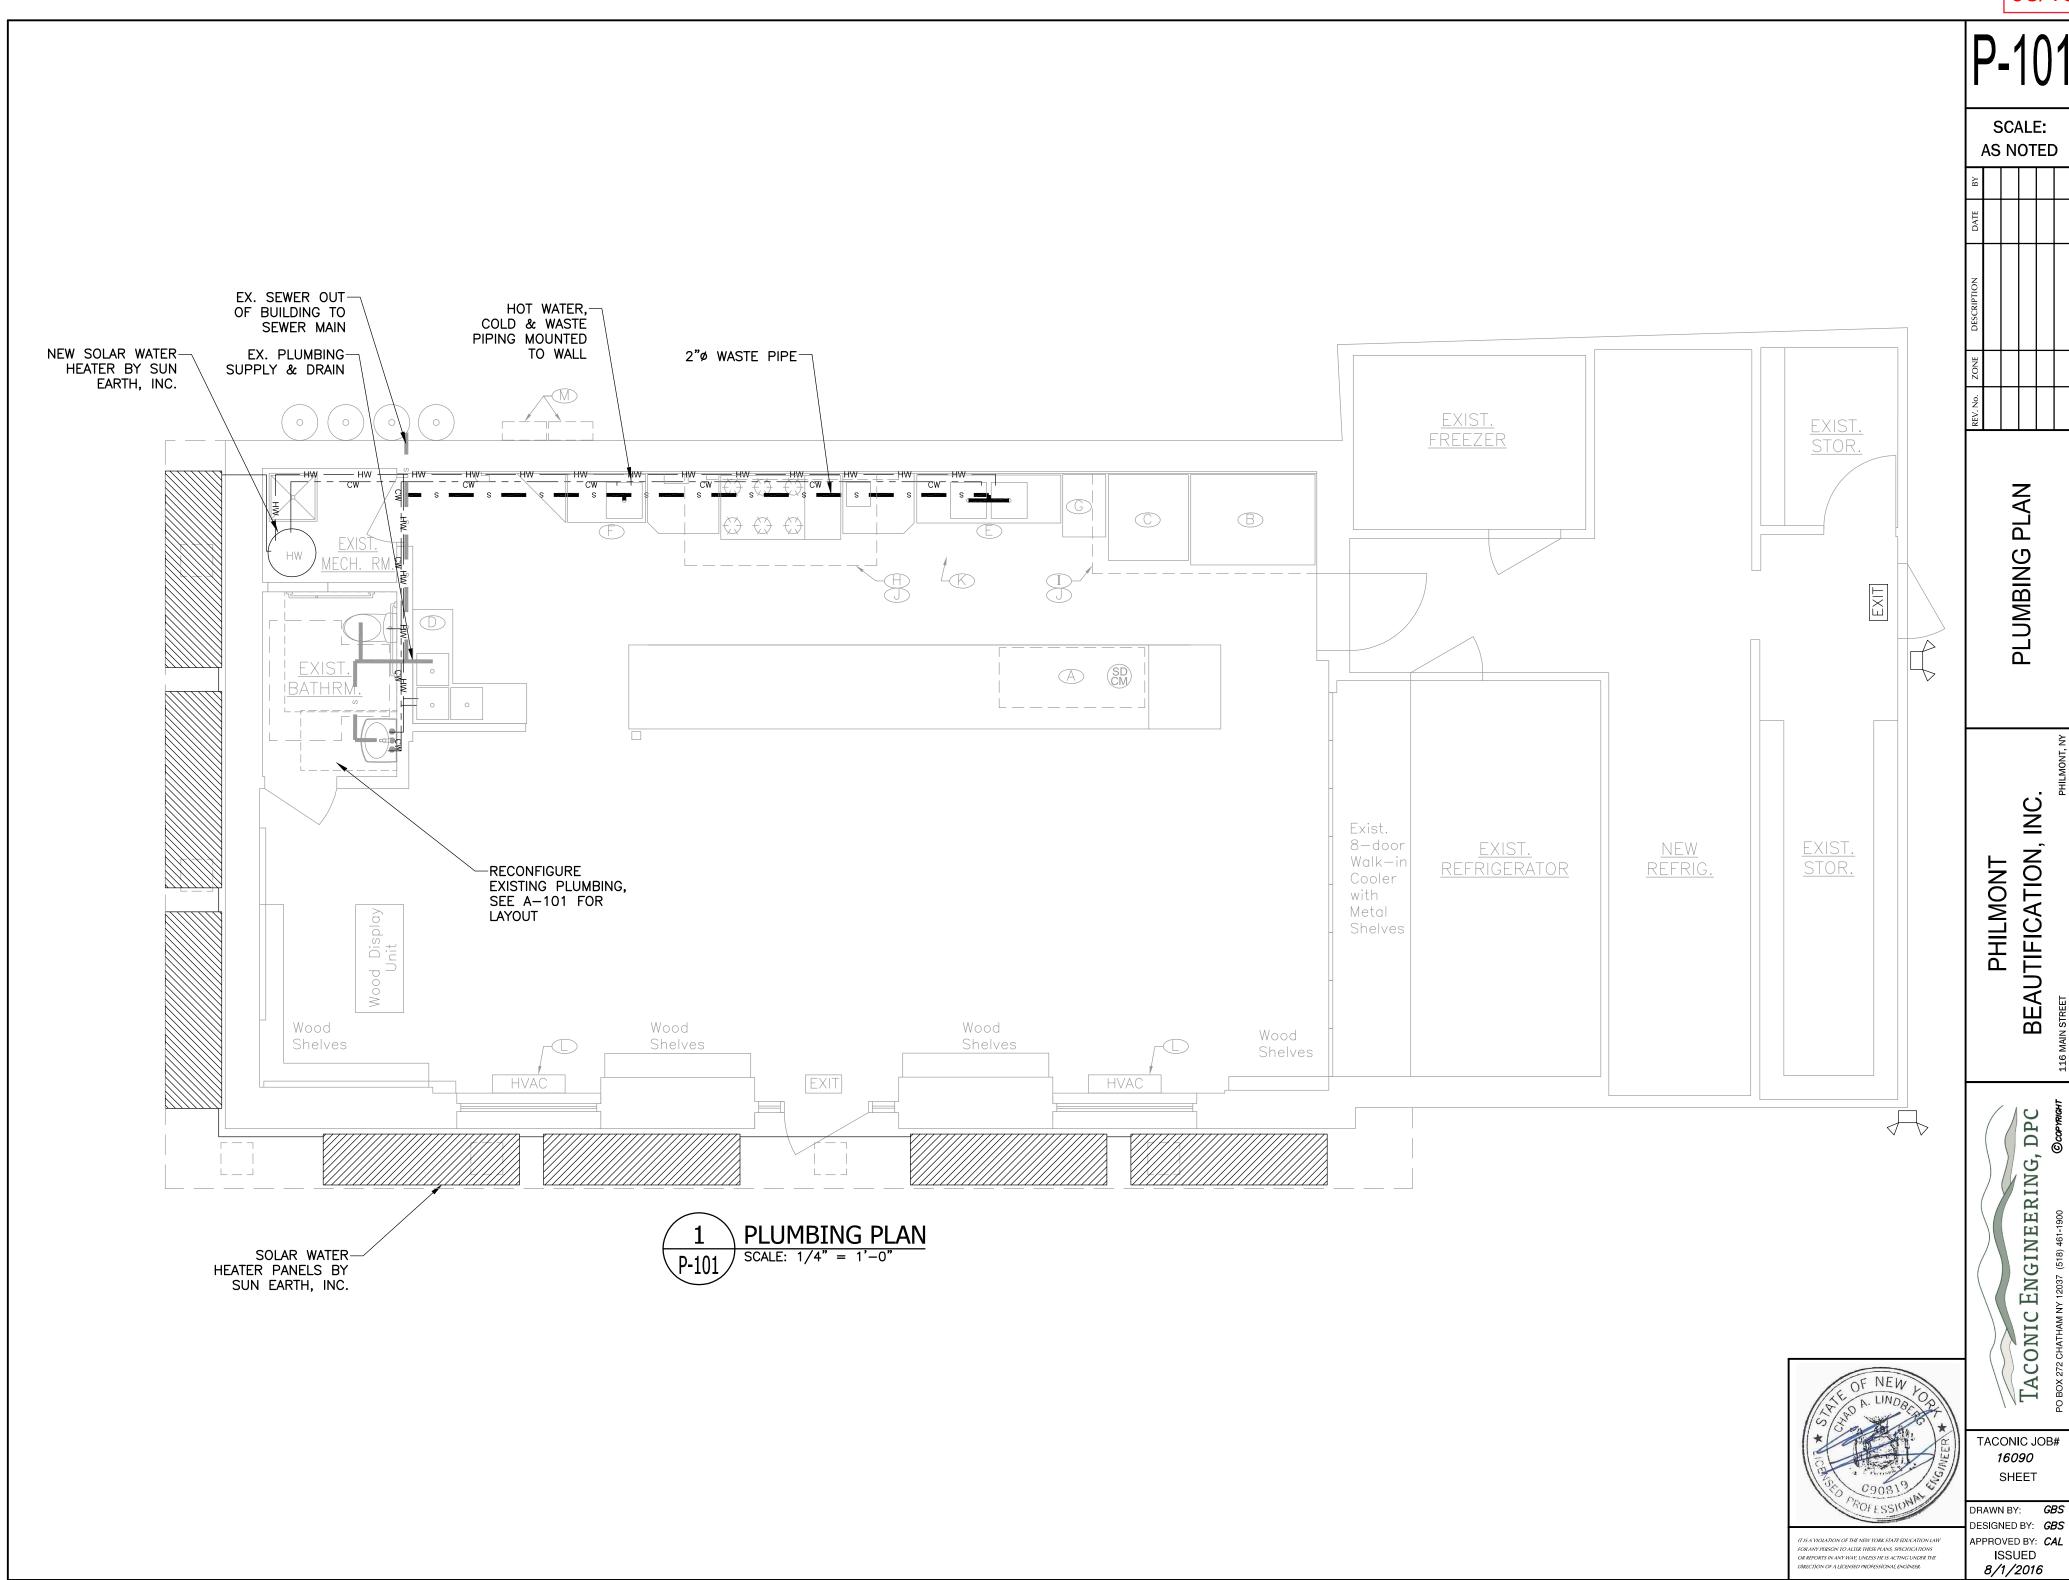


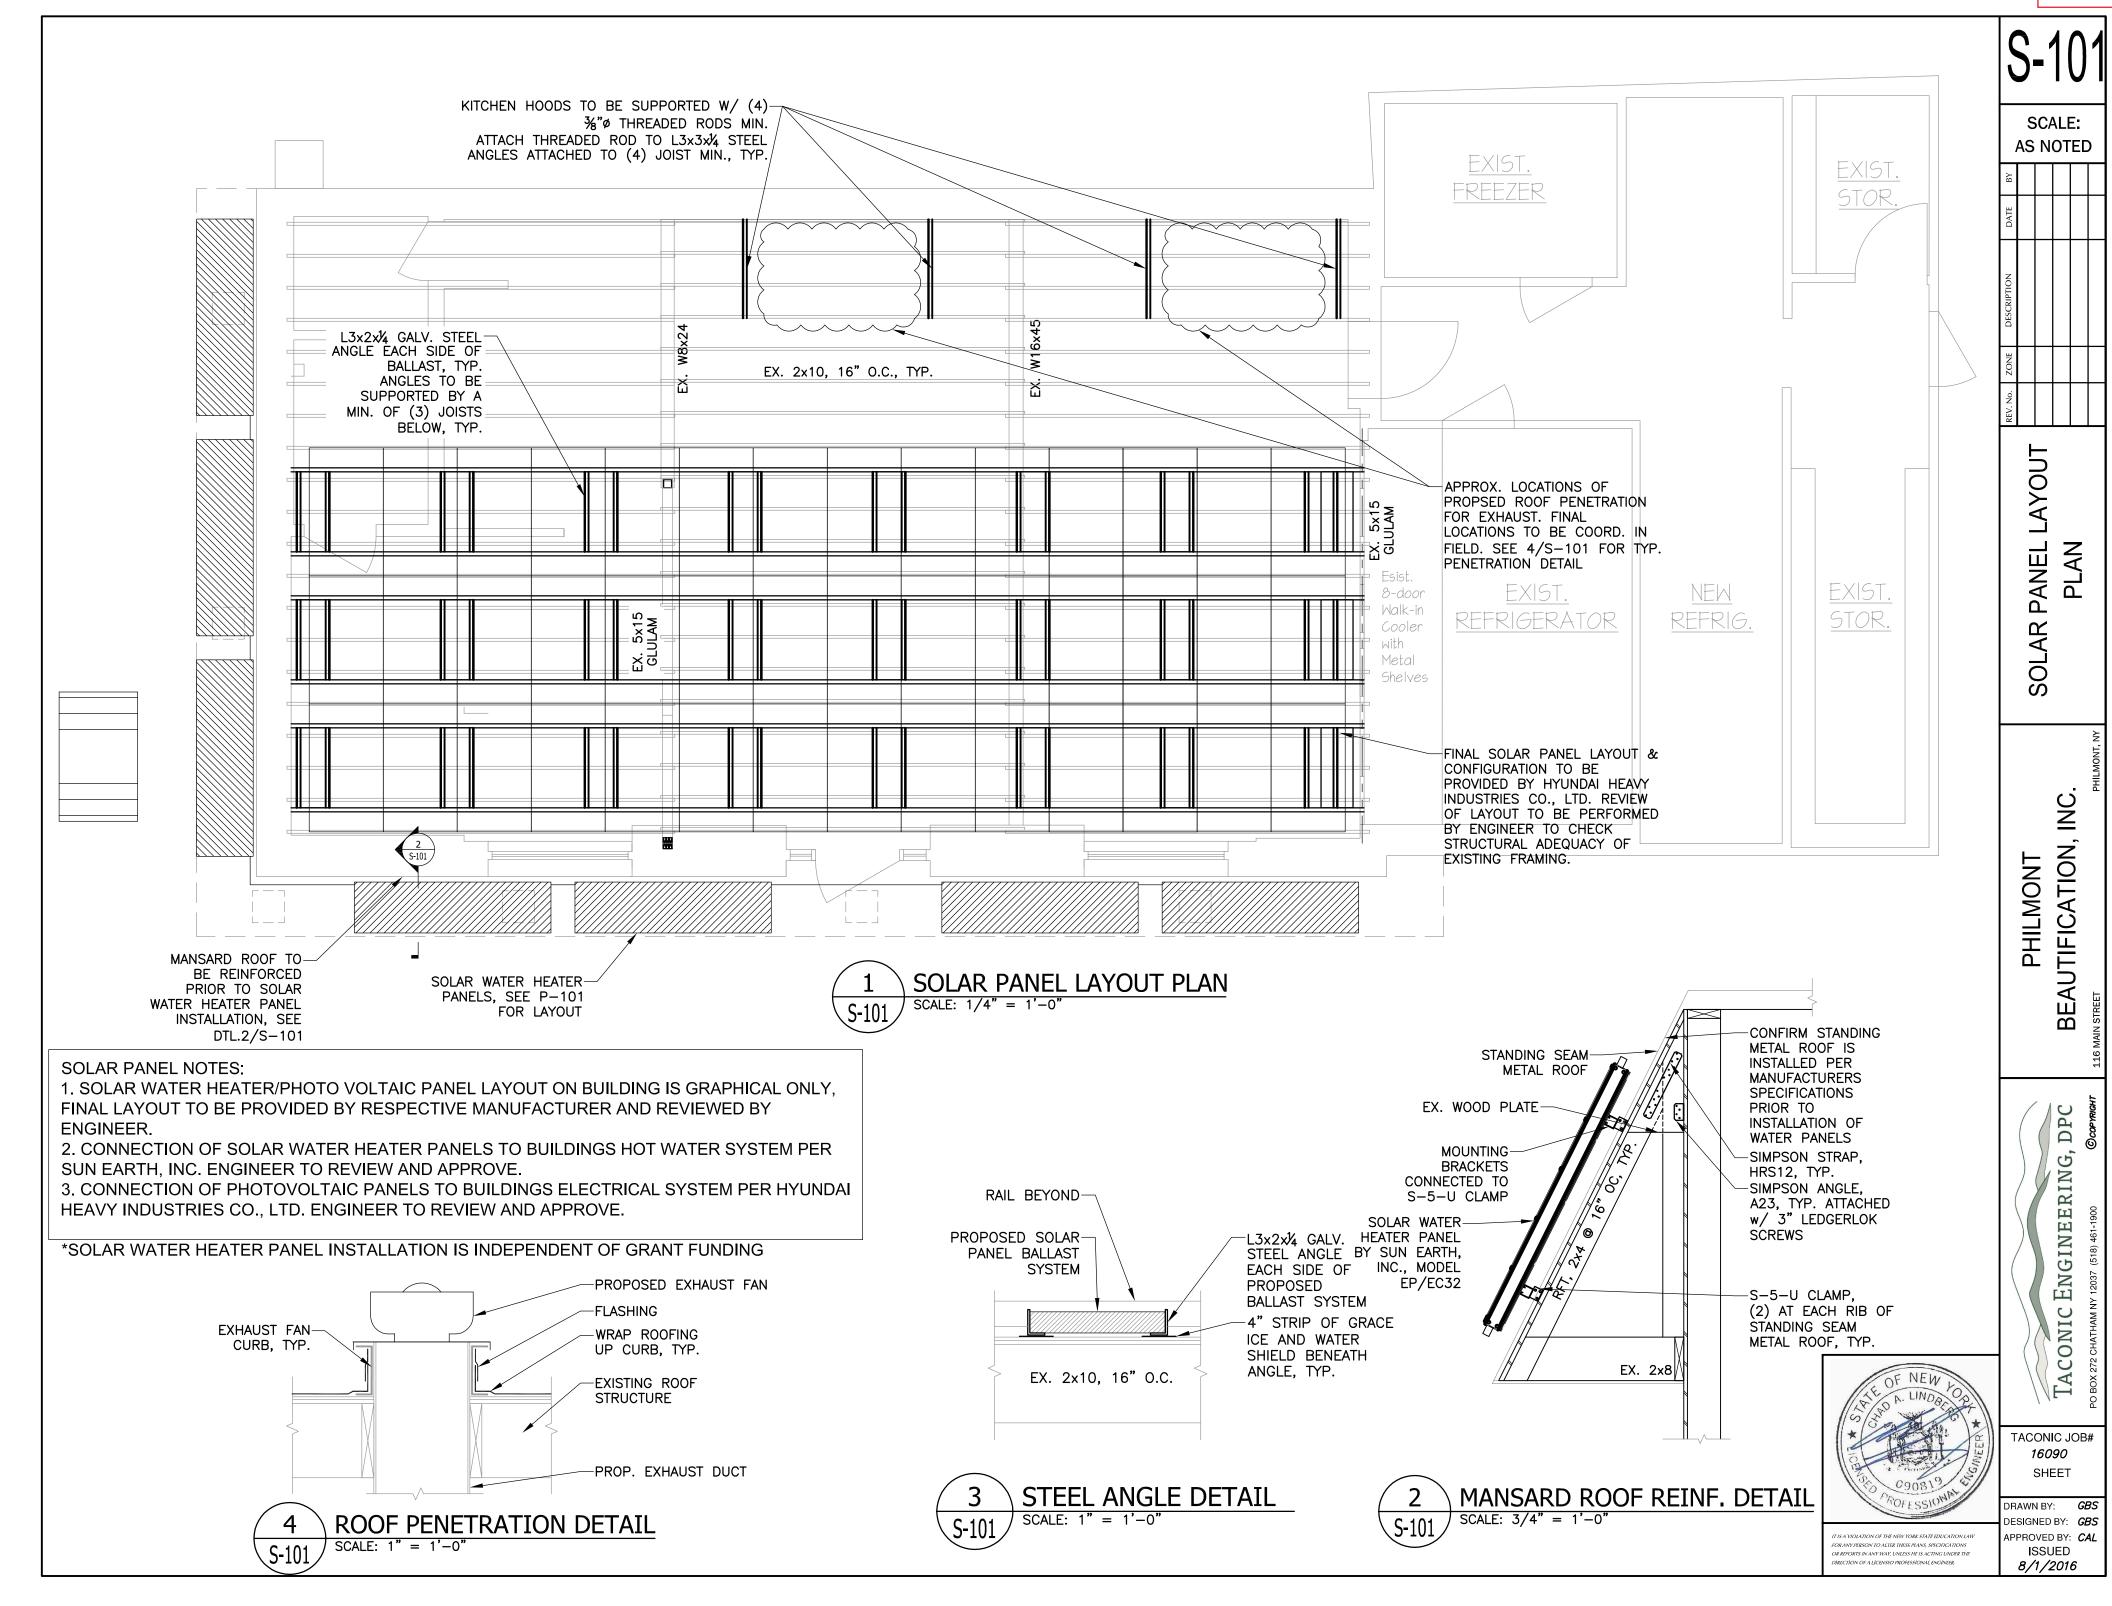
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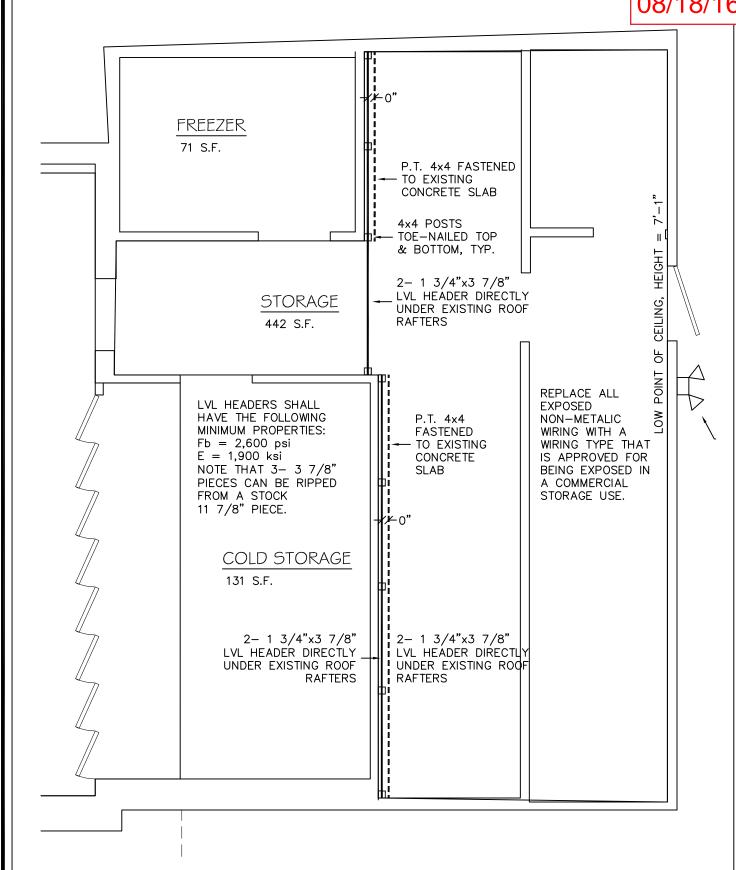
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DRAWN BY: GBS DESIGNED BY: GBS APPROVED BY: *CAL* ISSUED 8/1/2016







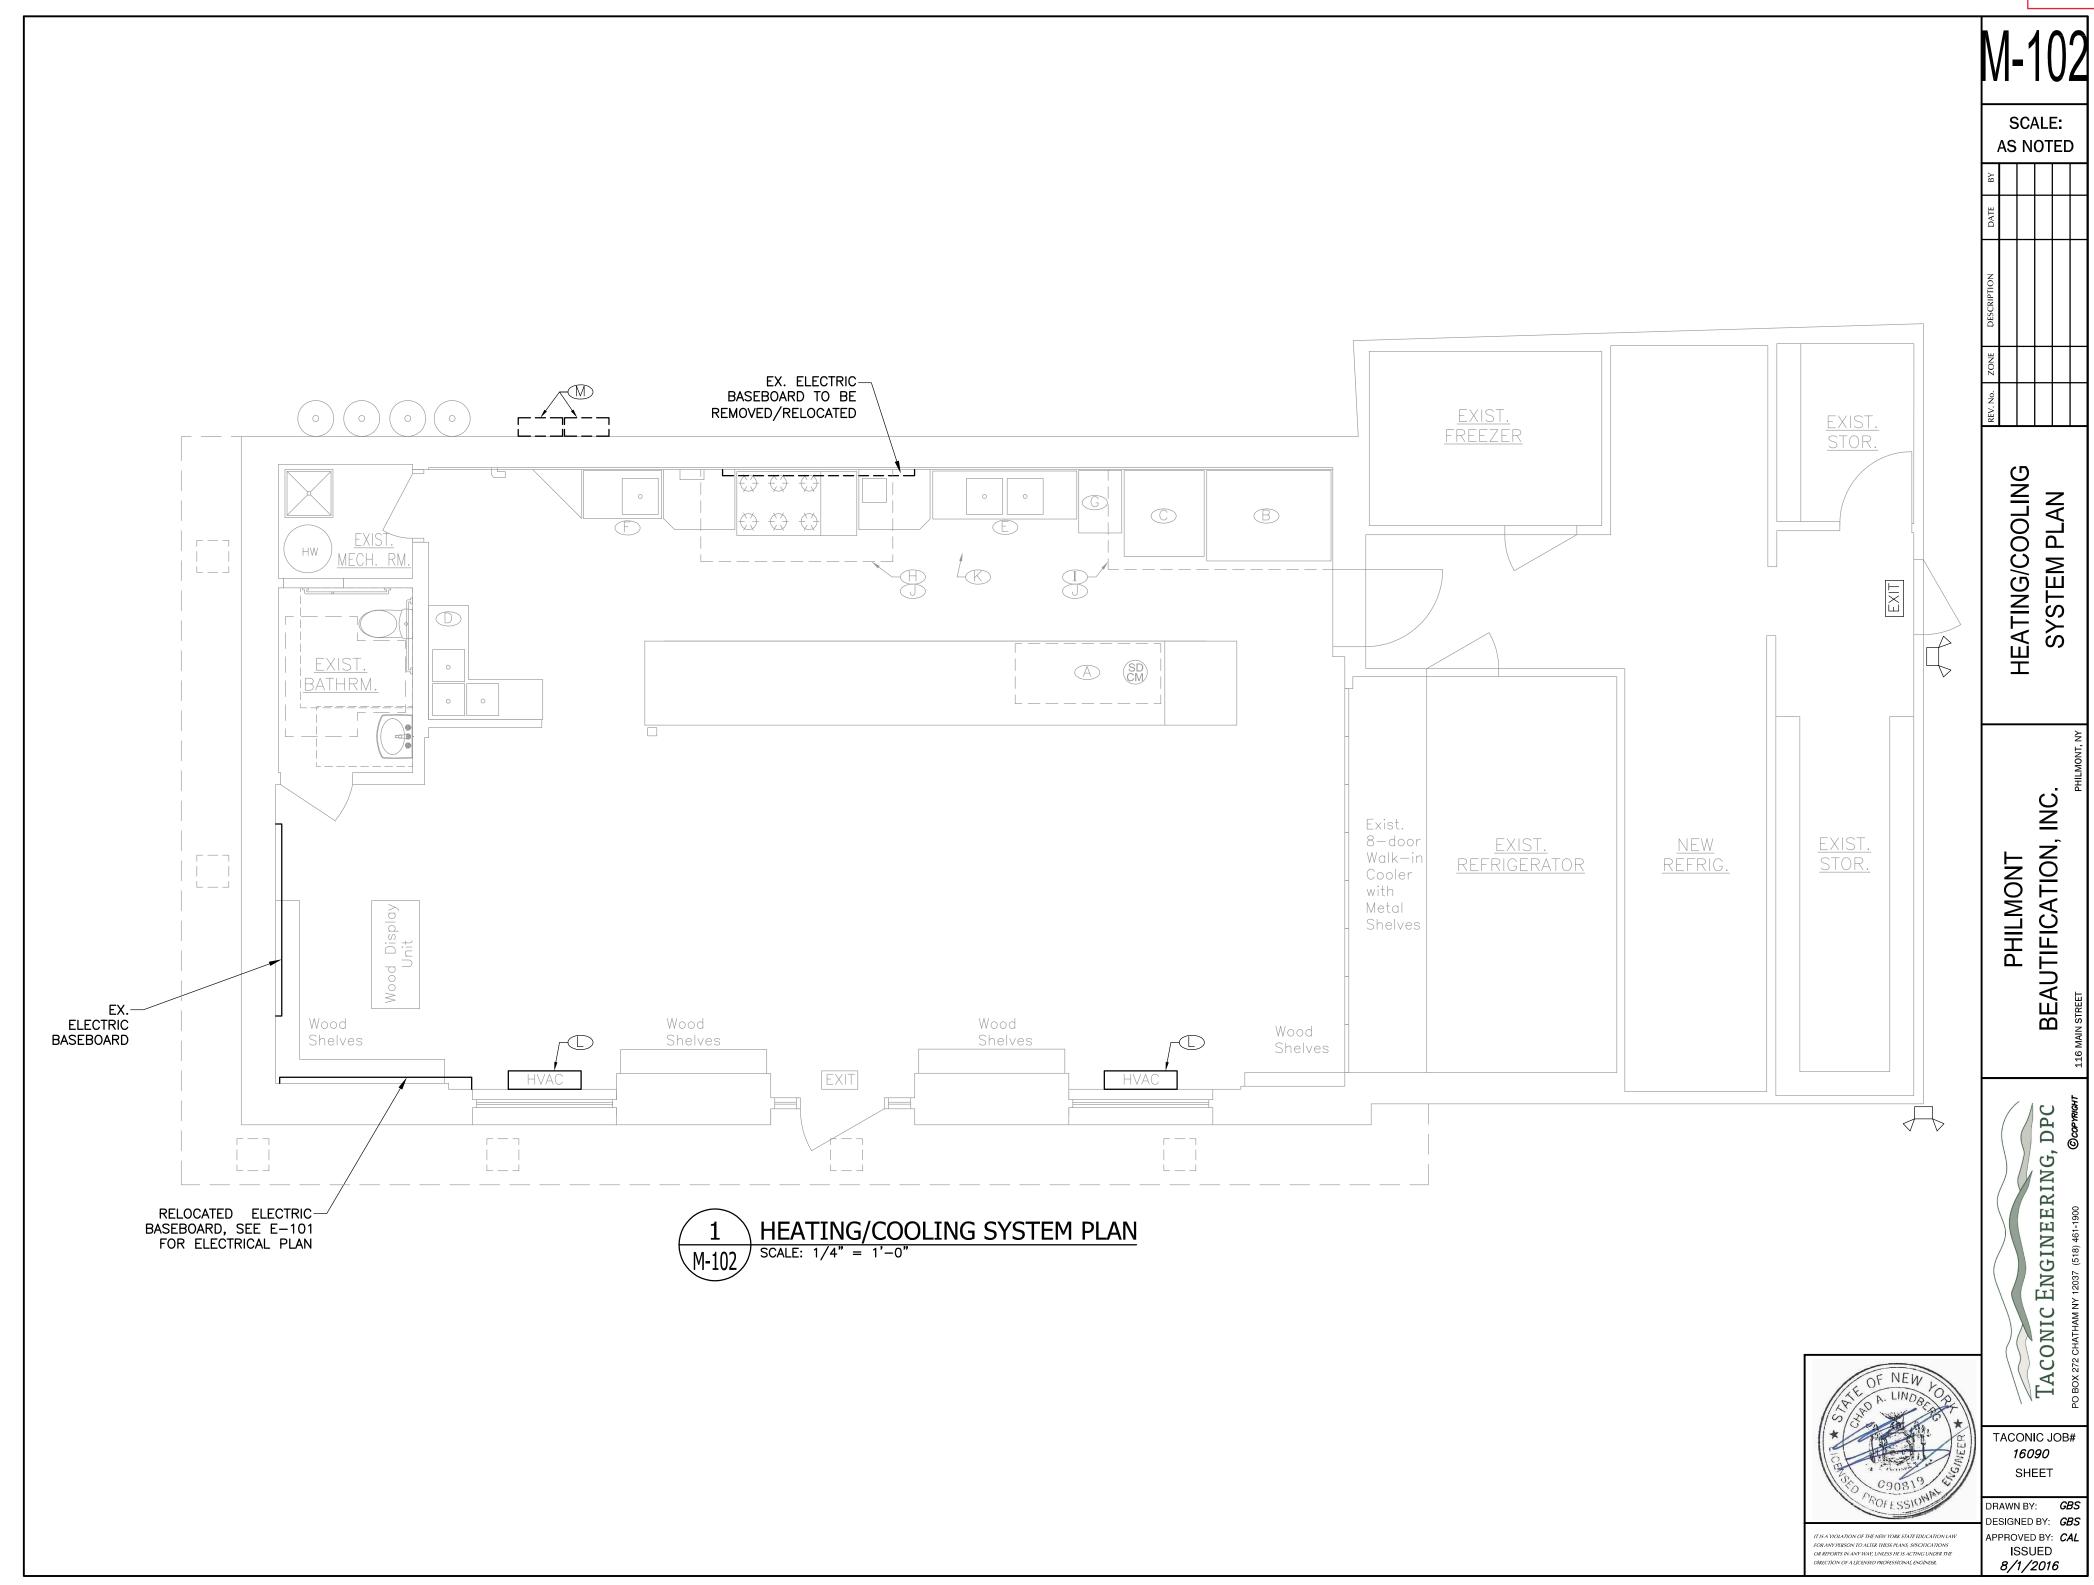

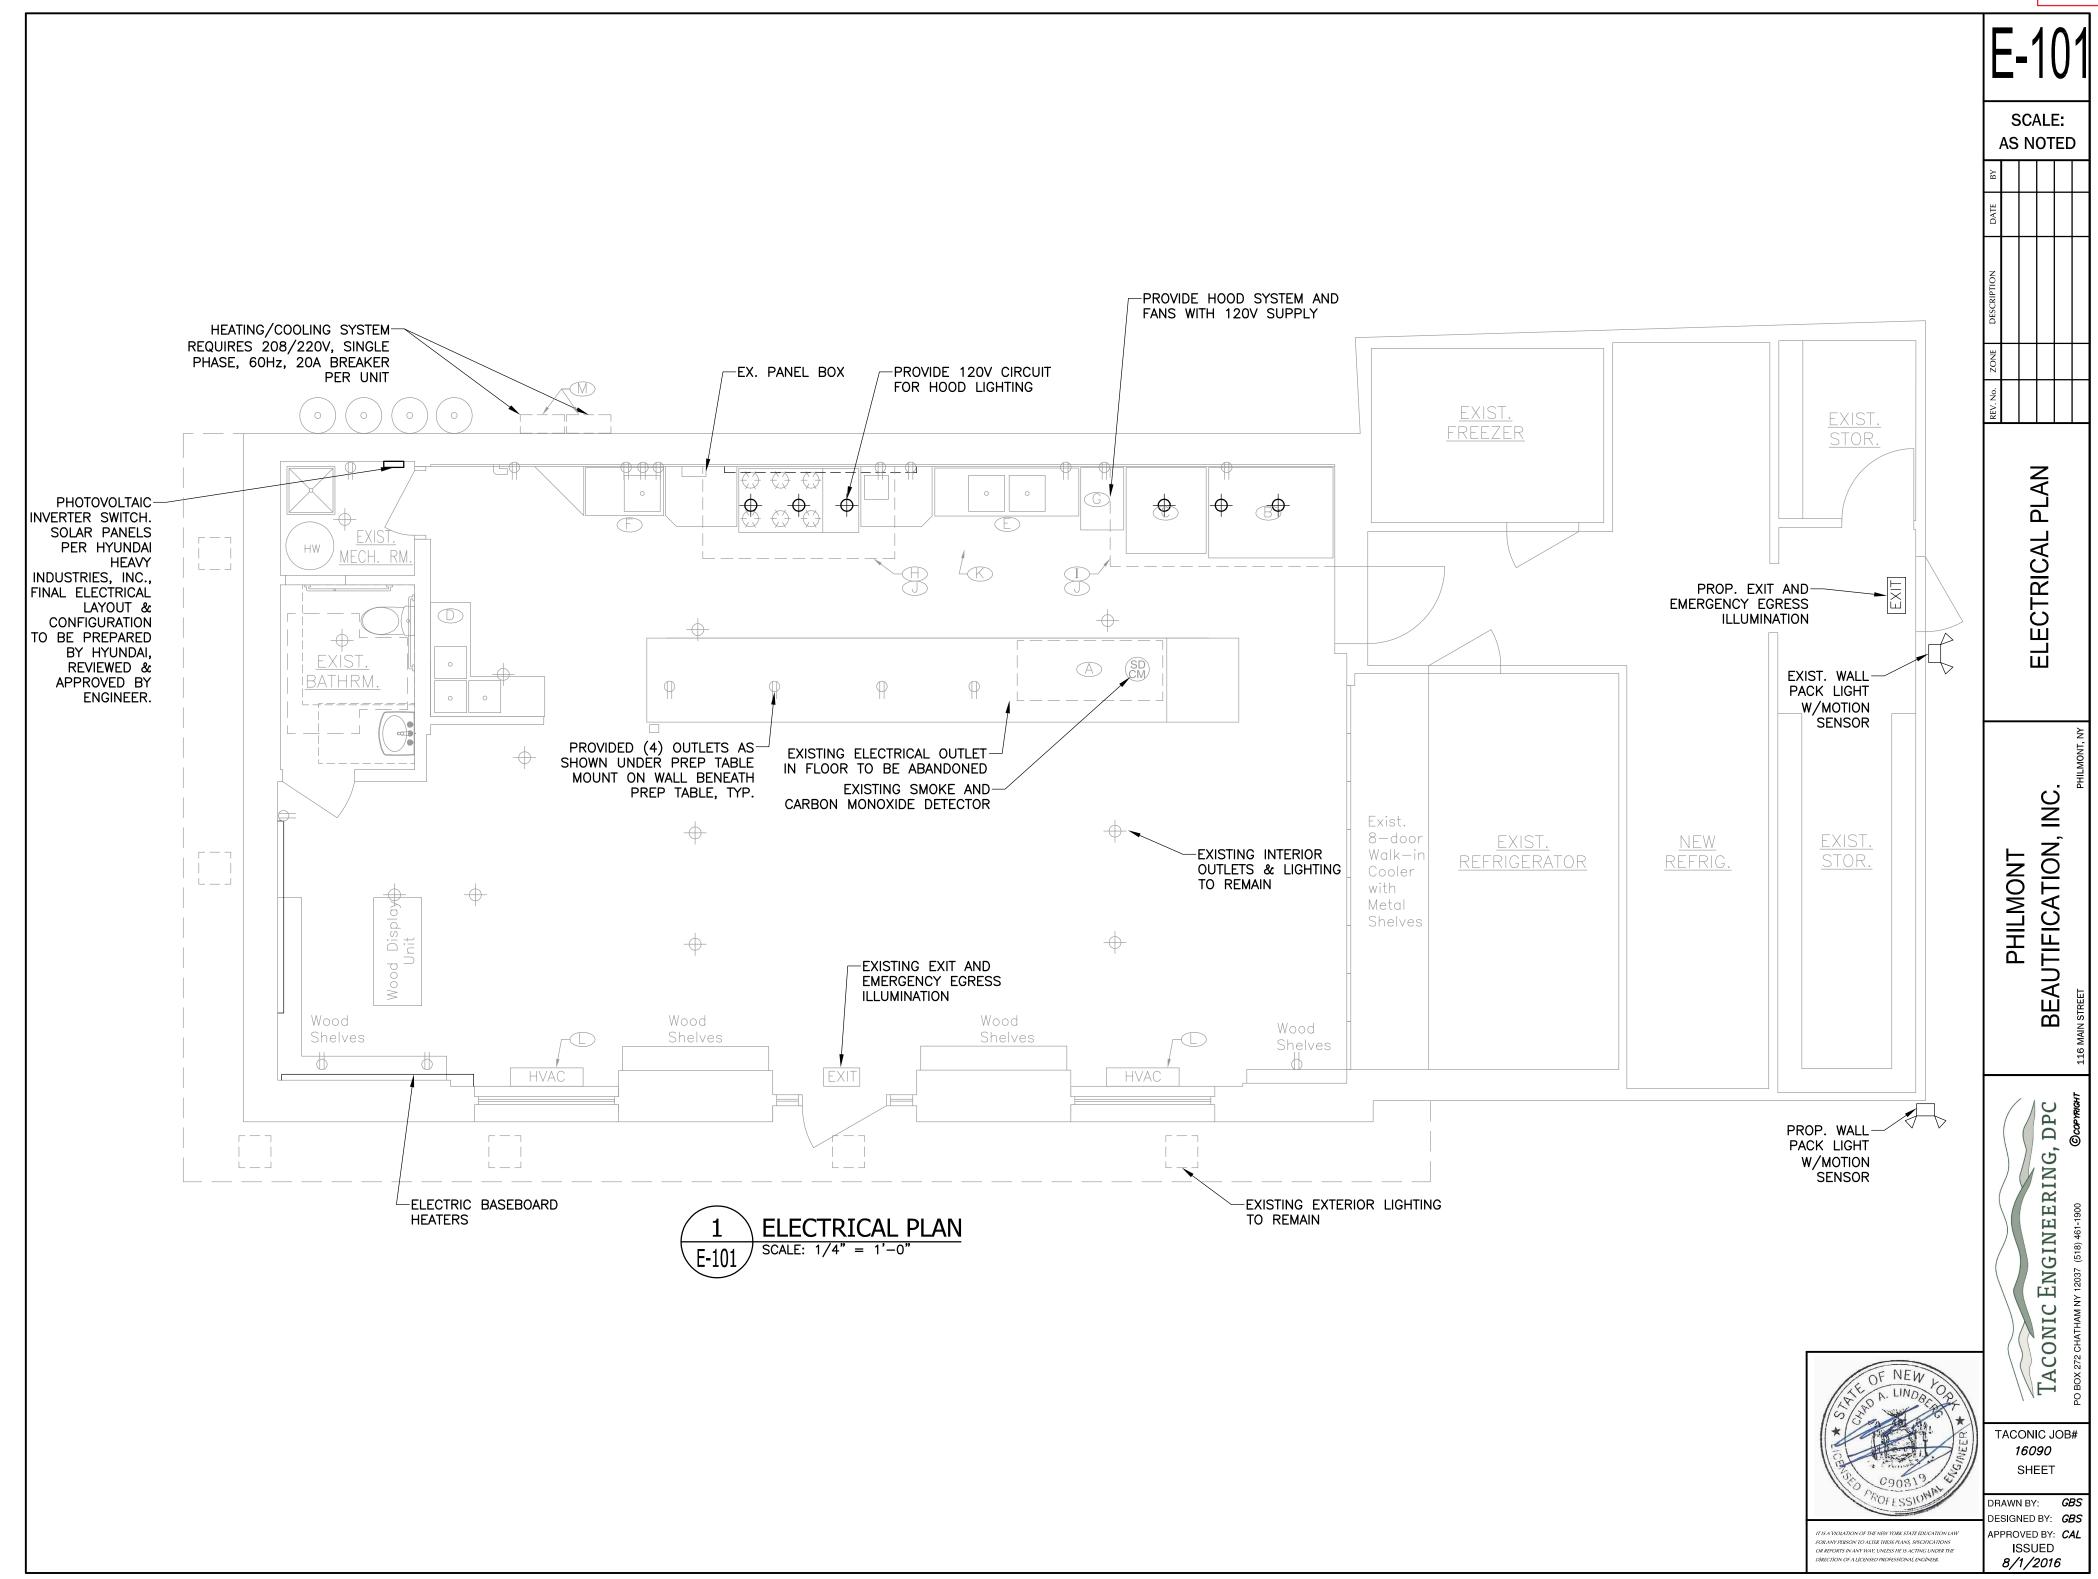CHRIS HOPPE, P.E. 61 SUMMIT ST. PHILMONT, NY 12565

PHONE: 518-755-5155

AD-1

JOB: Philmont Market & Cafe

DATE: March 18, 2015

SCALE: 1/4"=1'-0"

SHEET: PARTIAL FLOOR PLAN

HCR - 11 08/18/16

